


**LOCATION MAP**  
SCALE: 1" = 1/2 Mile

**LEGEND**

- EXISTING POWER POLE / PROPOSED POLE
- APPROXIMATE PROPERTY LINES
- APPROXIMATE PROJECT PARCEL
- SETBACKS TO SOLAR PANEL RACKING
- EXISTING GRADE CONTOUR LINES (10 FOOT INTERVALS)
- PROPOSED GRADE CONTOUR LINES (10 FOOT INTERVALS)
- PROPOSED GRADE CONTOUR LINES (2 FOOT INTERVALS)
- EXISTING TREELINE
- EXISTING OVERHEAD POWER
- EXISTING BARBED WIRE FENCE
- EXISTING GRAVEL ROAD
- PROPOSED PROJECT FENCE
- PROPOSED UNDERGROUND POWER
- PROPOSED OVERHEAD POWER
- PROPOSED CONTINUOUS SILT FENCE
- PROPOSED TREELINE
- PROPOSED TREE CLEARING
- PROPOSED SWITCH GEAR PAD & TRANSFORMER PAD
- PROPOSED FIXED TILT SOLAR PANEL RACKING
- DELINEATED WETLAND
- PROPOSED 15' WIDE GRAVEL ACCESS DRIVE
- LIMIT OF DISTURBANCE
- PLANTING AREA FOR VISUAL SCREENING

**NOTES:**

1. ASPECTS OF PLAN ARE APPROXIMATE AND DERIVED FROM AERIAL PHOTOGRAPHY.
2. THE HORIZONTAL COORDINATE SYSTEM IS BASED ON NAD83 MAINE STATE PLANES, EAST ZONE (US SURVEY FEET). ELEVATIONS ARE BASED ON THE NAVD88 (US SURVEY FEET).
3. EXISTING GROUND CONTOUR ELEVATIONS ARE BASED ON LIDAR DEM DATA FROM THE MAINE LIDAR PROJECT, 2017 LIDAR QL2 - DELIVERY AREA #2 IN AROOSTOOK, HANCOCK, PENOBSCOT, PISCATAQUIS, SAGADAHOOC, SOMERSET, AND WASHINGTON COUNTIES, MAINE.
4. UTILITIES ARE NOT WARRANTED TO BE COMPLETE OR ACCURATE. CONTRACTOR SHALL CONTACT DIG SAFE BEFORE BEGINNING ANY EXCAVATION.
5. THIS IS IN NO WAY A BOUNDARY SURVEY. PROPERTY LINES SHOWN ARE FROM A BOUNDARY SURVEY COMPLETED BY SACKETT AND BRAKE SURVEY INC. FOR THE GARDNER LAND COMPANY INC. PROPERTY, DATED AUGUST 24TH, 2020.
6. THIS IS A PRELIMINARY DESIGN PLAN. FINAL DESIGN WILL BE MODIFIED TO MATCH EQUIPMENT PURCHASED AND POSSIBLE PERMIT CONSTRAINTS REVEALED DURING PROJECT'S REVIEW.
7. ENVIRONMENTAL SITE REVIEW DATA IS BASED ON INFORMATION DELINEATED BY BOYLE ASSOCIATES IN AUGUST, 2020.

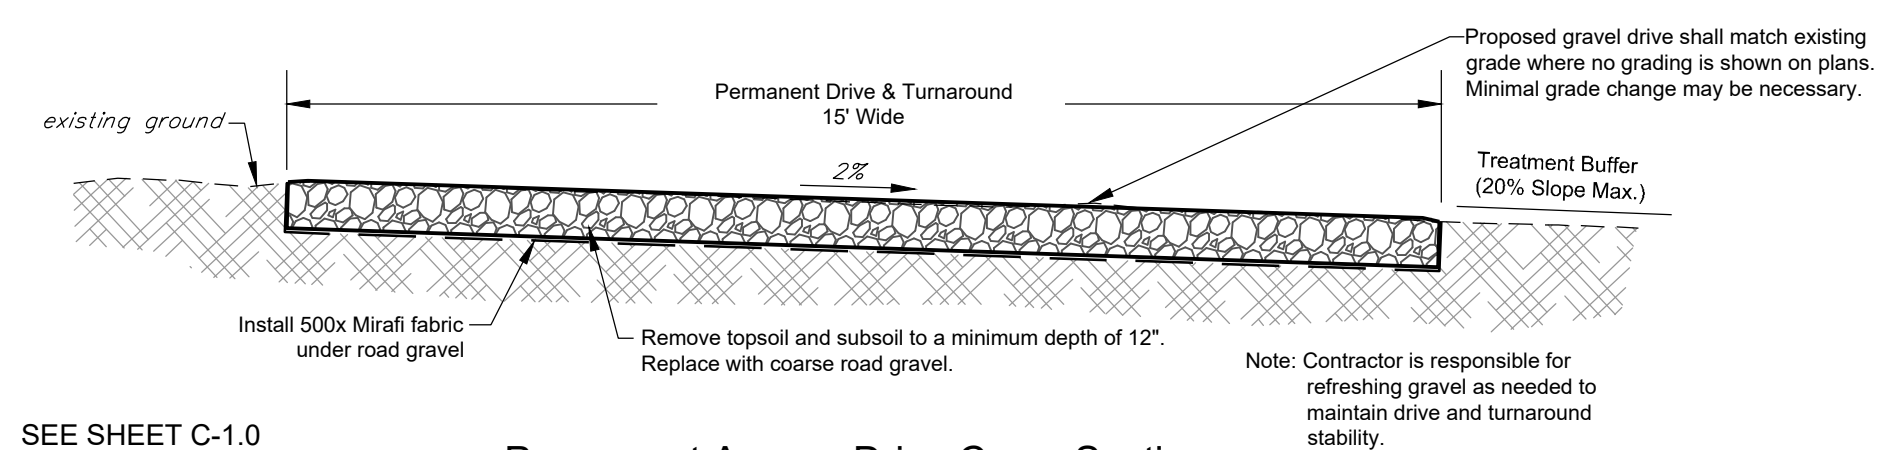

SEE SHEET C-1.0 FOR NOTES


**Permanent Access Drive Cross Section**

**GREENVILLE  
CSG  
SOLAR**

Greenville, Maine



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Berry, Huff, McDonald, Milligan Inc.  
Engineers, Surveyors

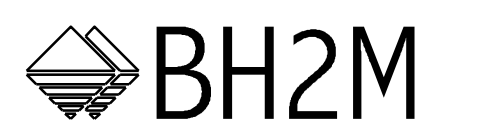28 State Street Tel. (207) 839-3771  
Gorham, Maine 04038 Fax (207) 839-8250

**ISSUED FOR PERMITTING  
NOT FOR CONSTRUCTION**

MAPPING SOURCE DATA USED FOR PLAN COMPILATION

Civil Engineering:

Krebs and Lansing Consulting Engineers, Inc.  
164 Main Street, Suite 201  
Colchester, Vermont 05446

Environmental:

Boyle Associates  
254 Commercial Street  
Merrill's Ward, Suite 101  
Portland, ME 04101

Stormwater:

BH2M Inc.  
28 State Street  
Gorham, ME 04038



STANDARD GRAPHIC SCALE (1" = 100')  
VALID WHEN PLOTTED ON 24" BY 36" MEDIA

REV. NO.	REVISIONS/COMMENTS	DATE

DRAWING TITLE:

**GREENVILLE CSG SOLAR  
OVERALL SITE PLAN**

DATE of Issue: 12/16/2020

Drawn by: EJM Checked by: IAJ

Project No.: 20999 Scale: 1" = 100'

Drawing No.: Rev No.:

**C-1.0**